### BOROUGH OF OAKLAND BERGEN COUNTY, NEW JERSEY

## Date Received Fee Submitted APPLICATION FOR RESIDENTIAL VARIANCE FROM Jurisdiction Date \_\_\_\_\_ LOT AREA AND SETBACK REQUIREMENTS Complete Date Date 5/10/23 Date by \_\_\_\_ Board Action NOTE: APPLICATION SETS MUST BE COLLATED AND SUBMITTED IN PACKET FORM FOR PROCESSESSING. FOR OFFICIAL USE ONLY Check nature of the application: ☐ Appeal interpretation of Building Inspector. (Type A) Bulk variance, requesting relief from dimensional zoning code requirement (Type C). ☐ Use variance from zoning code permitted uses. (Type D) The undersigned, as Applicant/Owner of the subject property listed below hereby makes application to the Borough of Oakland Board of Adjustment for relief from residential zone requirements relating to lot area or setback requirements of the Borough Zoning Ordinance pursuant to N.J.S.A. 40:55D-70 C (1) or C (2) and applicable laws of the Borough of Oakland in order to: (briefly describe proposal) Construct a second story addition to existing single-family dwelling. 1. APPLICANT INFORMATION **Stephen and Jennifer Mawhinney** Name: Address: 98 Grove Street, Oakland, NJ 07436 Telephone & Email address (include fax number if desired): 201-757-3295, steve.jenni.mawhinney@gmail.com Applicant is a: (check applicable status) Corporation Partnership LLC Individual(s) If applicant is a corporation or a partnership, please list the names and addresses of persons having a 10 % interest or more in the corporation or partnership on a separate sheet and attach to this application. f. Relationship of applicant to property (check applicable status): x Owner Purchaser under contract \_\_\_\_\_ Lessee

\_\_\_\_ Other (please specify): \_\_\_\_\_

	g.	Name:					
		Address:					
		Telephone:Fax:					
2.	PRO	PROPERTY INFORMATION					
	a.	Street address 98 Grove Street, Oakland, NJ 07436					
	b.	Tax Map Block(s)Lot(s)Lot(s)					
	c.	Zone District RA-3					
	d.	Lot Area 13,881 sq.ft Lot Dimensions 159.72' x 100.11'					
	e.	Has present or previous owner or applicant held title to or held any interest in					
		Adjoining property at any time? Yes Nox If yes, explain nature of					
		interest.					
	f.	Lot length & width: 159.72' x 100.11' Interior of corner lot? no					
	g.	Number of Streets the lot has frontage on:Lot square foot area: 13,881 sq.ft					
	h.	Property is located (check applicable status):					
		Within 200 feet of another municipalityAdjacent to a State Highway					
		Adjacent to an Existing or proposed County roadAdjacent to other County land					
	Note: If any category is checked, notification concerning this application to the approis required.						
	i.	Property is sewered Septic systemX					
	j.	Current number of bedrooms 3 Proposed number of bedrooms 3					
	k.	Current number of bathrooms 1.5 Proposed number of bathrooms 3.5					
	1.	Height of building: Existing Stories Feet					
		Proposed Stories 2.5 Feet 35					
	m.	Percentage of lot occupied by building:					
		Now: <u>9.7</u> % With proposed addition: <u>11.18</u> %					
	n.	Setback from property lines:					
		Front Rear Right Side Left Side a. Existing: 34' 103' 21.6' 17.3'					

		b. Proposed:	32' (at cantilever)	101' (at cantilever)	21.6′	17.3′	<u> </u>		
	o.	Please list prior applications or municipal actions regarding this property:							
		n/a							
3.	NΑ	THRE OF APPL	JCATION: This i	s an application for	r a variance fr	om the strict a	pplication of the Borough		
٥,	s located. The proposed								
		-		•			h (the Zoning Officer		
			to determine the ap	- •	_				
	Rel	ief Requested:							
	Sec	etion		Required			Proposed		
		apter 59 tachment 5 - S	chedule A	40'			32'		
					······································				
4.	RI	REASONS FOR REQUEST IN SUPPORT OF THIS APPLICATION							
	This variance is sought because of (check applicable):								
	(a)Exceptional narrowness of property. (b) Exceptional shallowness of property.								
	(c)	Shape of p	property.	(d)Exception	onal topograpl	hic or physica	features of the site.		
	(e) X Other extraordinary or exceptional situation.								
		Describe property features or situation if items (d) or (e) are checked. You may attach additional information is							
	Οι	desired to support your application.  Our home is considered to be existing nonconforming because it currently does not meet							
		the 40' front yard setback requirement. We are seeking to construct a second floor addition that includes a 2' cantilever. This will maintain the current setback of 34' on the first floor							
5.	bu	but will reduce the setback to 32' at the cantilever. OTHER REQUIRED INFORMATION							
Attach certification of payment of taxes from Tax Collector.									
Attach completed checklist.									
Attach current survey showing existing & proposed improvements and septic system if applicable. #3 on checklist.							if applicable. Refer to item		

### 6. VERIFICATION AND AUTHORIZATION

Applicant's Statement: I hereby certify that the above statements made by me and the statements and
information contained in the papers submitted in connection with this application are, to the best of my
knowledge, true and accurate.
Applicant's Signature 5/10/23 Date
Sallzy Applicant's Signature  5/10/23 Date
Owner's Statements I the system of height the system of the system described in this application however
Owner's Statement: 1, the undersigned, being the owner of the property described in this application, hereby
consent to the making of this application and the approval of the plans submitted. I further consent to the
inspection of this property in connection with this application as deemed necessary by the municipal
agency.
Stant John 5/10/23 Owner's Signature Date
Subscriber and sworn to before me this
$10^{1}$ day of May, $2023$ (Year)
(Notary
HEATHER E. GALLOWAY Commission #2300950 Notary Public, State of New Jersey My Commission Expires May 28, 2023

#### **ZONING TABLE**

This MUST be completely filled out in order for your application to be deemed complete ZONE OF SUBJECT PROPORTY: RA-3

1 1 1 1 1 1 1 1 1 1 1 1 1 1 1 1 1 1 1	REQUIRED	EXISTING	PROPOSED
Lot Area	15,000 sf min	13,881 sf	13,881 sf
Lot Width	100 ft mln	100.11 ft	100.11 ft
Lot Depth		159.72 ft	159.72 ft
Bullding Coverage*  (calculated: total building footprint square footage divided by lot area x 100%)	<b>20</b> % max	9.7 %	<u>11.18</u> %
Impervious Coverage**  (calculated: total Impervious footprint square footage divided by lot area x 100%)	_ <b>40</b> _% max		_19.07_%
Front Setback		ft	ft
Side Setback	ft mln	17.3 ft (Left) 21.6 ft (Right)	17.3 ft (Left) 21.6 ft (Right)
Rear Setback	35 ft min	_103_ft	_101ft
Building Height		ft storles	

<sup>\*</sup>Building Coverage: that percentage of a lot covered by the roof(s) of all principal and accessory building(s), including roofed over porches and similar extensions of a building such as roofed decks.

<sup>\*\*</sup>Impervious Surfaces: surfaces covered by roofs, pavement, walks, patios, and other materials so that underlying soils are highly resistant to infiltration of water. This includes all buildings, porous paving, paver blocks, gravel, crushed stone, decks, patios, elevated structures, and other similar structures, surfaces, or improvements.



## **BOROUGH OF OAKLAND, NEW JERSEY**

TO:

Planning Board

FROM:

Glen Turi

This is to advise you that on April 25, 2023 a denial was issued to the resident Stephen Mawhinney & Jennifer Mawhinney for the location 98 Grove Street, Oakland, NJ 07436

Block: 3401 Lot: 28

Zoning District:

RA-3

For: Addition

For the following reasons:59-Attachement 5

1) Front Yard Setback: Minimum 40 Feet, Proposed 32 Feet

The Ordinances pertaining to this application are:

Chapter 59-Attachment 5

Fee: \$50.00 Paid by: # Check #1113 LOD: #Z-04250001

An appeal to the Board of Adjustment of the determination must be made within twenty (20) days of the date of this determination.

Glen Turi

Zoning Official

# MAWHINNEY RESIDENCE 98 GROVE STREET OAKLAND, NEW JERSEY

# GENERAL NOTES

1) INFORMATION SHOWN IN THE DRAWINGS ARE GENERAL IN NATURE & REPRESENT AN OVERALL DESIGN CONCEPT. THEY ARE PREPARED WITH THE INTENT TO DEMONSTRATE THE OVERALL DESIGN, ARRANGEMENT AND METHOD OF ASSEMBLY OF THE VARIOUS COMPONENTS. THE CONTRACTOR IS ASSUMED TO TO HAVE REVIEWED THESE PLANS, HAVING SEEN THE SUBJECT PROPERTY, AND IS CAPABLE OF EXECUTING THE DETAIL WORK NECESSARY TO ACHIEVE THE INTENDED RESULT IN A MANNER CONSISTENT WITH QUALITY WORKMANSHIP WITHIN THE REGION. IT IS INCUMBENT UPON THE CONTRACTOR TO REPORT IN WRITING TO THE ARCHITECT, PRIOR TO THE SUBMISSION OF BID, ANY QUESTIONABLE ERRORS OR

2) DO NOT SCALE DRAWINGS- USE DIMENSIONS ONLY. CHECK AND VERIFY ALL CONDITIONS AND DIMENSIONS AT THE JOB SITE PRIOR TO CONSTRUCTION. ANY DISCREPANCIES AND / OR OMISSIONS SHALL BE BROUGHT TO THE ATTENTION OF THE ARCHITECT PRIOR TO THE SUBMISSION OF BIDS AND COMMENCEMENT OF WORK.

OMISSIONS, INTENT OR METHOD OF CONSTRUCTION.

3) THE CONTRACTOR SHALL FILE FOR, OBTAIN, AND PAY FOR ALL PERMITS AND APPROVALS, NO WORK IS TO COMMENCE UNTIL ALL APPROYALS ARE OBTAINED AND ALL PERMITS HAVE BEEN

4) ALL WORK SHALL COMPLY WITH THE "NEW JERSEY CONSTRUCTION CODE", "THE REGULATIONS OF THE NEW JERSEY CONSTRUCTION CODE", LOCAL ORDINANCES, AND UTILITY COMPANIES REGULATIONS, HAVING JURISDICTION.

5) ALL CONTRACTORS SHALL MAINTAIN CONTRACTORS LIABILITY PROPERTY DAMAGE INSURANCE, AND WORKMAN'S COMPENSATION INSURANCE. ALL OPERATIONS SHALL CONFORM TO ALL FEDERAL AND STATE SAFETY CODE REGULATIONS.

6) CONCRETE FOOTINGS AND SLABS, IF REQUIRED, SHALL HAVE MINIMUM ULTIMATE COMPRESSIVE STRENGTH OF 3,000 P.S.I. AFTER 28 DAYS.

1) ALL ELECTRIC WORK SHALL COMPLY WITH THE NATIONAL ELECTRIC CODE. CONTRACTOR SHALL CONNECT ALL APPLIANCES AND EQUIPMENT. PROVIDE CIRCUITING PER CODE TO WIRE ALL DEVICES SHOWN OR CODE REQUIRED.

8) ALL PLUMBING SHALL CONFORM TO THE NATIONAL STANDARD PLUMBING CODE.

9) HEAT AND AIR CONDITIONING SHALL BE PROVIDED BY CONTRACTOR.

10) ALL WORK SHALL BE GUARANTEED FOR A PERIOD OF ONE (1) YEAR FROM THE DATE OF FINAL COMPLETION OF THE

11) THE CONTRACTOR SHALL MAINTAIN THE SITE IN A NEAT, CLEAN MANNER AT ALL TIMES. AT COMPLETION OF WORK, THE CONTRACTOR SHALL THOROUGHLY BROOM CLEAN BOTH INTERIOR AND EXTERIOR AREAS. THE PROPERTY SHALL BE RETURNED TO THE ORIGINAL CONDITION.

12) ALL CONSTRUCTION SHALL BE PREPARED AND FINISHED TO CONFORM TO BUILDING STANDARDS.

13) CONTRACTOR SHALL PATCH AND REPAIR AS NECESSARY ALL EXISTING AREAS AFFECTED BY DEMOLITION AND CONSTRUCTION AND SHALL PREPARE SAID AREAS FOR NEW FINISH AS

14) CONTRACTOR SHALL BE RESPONSIBLE FOR PRESERVING THE INTEGRITY OF ALL FIRE RESISTANCE STRUCTURAL ELEMENTS, ANY VOIDS CREATED IN CEILINGS, FLOORS AND/OR WALLS ARE TO BE SAVED BY CONTRACTOR TO COMPLY WITH EXISTING CODES.

15) ALL NEW CONSTRUCTION AND EXISTING STRUCTURE TO REMAIN SHALL BE PREPARED AND FINISHED AS REQUIRED TO BUILDING STANDARD AND WHERE NEW WALL INCORPORATED ANY PORTION OF AN EXISTING WALL, MATERIALS SHALL MATCH, BOTH IN KIND AND THICKNESS AND SHALL BE FINISHED SMOOTH SO THAT NO SEAM OR PATCH IS VISIBLE.

16) CONTRACTOR SHALL COMPLY WITH SOIL EROSION CONTROL AGENCY REQUIREMENTS AND OBTAIN APPROVAL IF LOCALLY REQUIRED.

17) FRAMING LUMBER ( JOIST, GIRDERS, RAFTERS, PLATES, STUDS, SILLS, HEADERS, TRIMMERS, RIDGES AND VALLEYS) SHALL BE DOUGLAS FIR 15% CONSTRUCTION GRADE NO. 1. 25% CONSTRUCTION GRADE NO. 2 (EXTREME FIBER IN BENDING = 1450 P.S.I., MODULUS OF ELASTICITY = 1,700,000) SET ALL JOISTS AND GIRDERS WITH NATURAL CAMBER DOUBLE UP FLOOR JOISTS UNDER PARTITIONS RUNNING PARALLEL TO JOISTS AND UNDER TILE FLOORS. DOUBLE UP STUDS AT ALL OPENINGS, SUPPORT HEADERS ON STUDS, SUPPORT HEADERS LONGER THAN 1'-0" ON TWO STUDS EACH END. CUTTING NOTCHING AND DRILLING OF WOOD JOISTS SHALL BE PER "UCC REHAB" CODE. KEEP WOOD FRAMING MINIMUM 2" AWAY FROM FLUES, CHIMNEYS

PROVIDE TWO ROWS SOLID BRIDGING AT FLOORS AND ATTIC CEILING FRAMING FOR EACH SPAN INCREMENT OF 8'-0". MINIMUM HEADROOM AT STAIRS 6'-8". ALL HEADERS OVER DOORS AND WINDOWS TO BE (2) 2" x 8" ON TWO STUDS ON EACH SIDE OF OPENING. ALL OPENINGS OVER 6'-0" WIDE SHALL HAVE (2) 2"XIO" HEADER ON THREE STUDS EACH SIDE OF OPENING TYPICAL ALL DOOR AND

18) PROVIDE SMOKE DETECTORS USING AN AC PRIMARY SOURCE AS POWER SUPPLY, PER "UCC REHAB" CODE.

WINDOW HEADERS UNLESS OTHERWISE NOTED.

19) STRUCTURAL DESIGN LOADS: ROOF RAFTERS = 30 LB6.L.L. + 10 LB6.D.L. = 40 LB6.T.L. ATTIC FLOOR = 20 LBSLL. + 10 LBS.DL. = 30 LBS.TL. 2ND FLOOR = 30 LBS.L.L. + 15 LBS.D.L. = 45 LBS.T.L. 1ST FLOOR = 40 LBSLL. + 15 LBS.DL. = 55 LBS.TL.

20) ENERGY CODE COMPLIANCE: THIS BUILDING COMPLIES WITH THE CODE THE WINDOW AREA IS NOT MORE THAN 15% OF WALL AREA, THE WALLS HAVE A MINIMUM OF R-11 INSULATION. THE CEILINGS HAVE A MINIMUM OF R-19 INSULATION.

21) ATTIC SPACE SHALL BE VENTED WITH APPROVED VENTING, NET AREA OF 0.0033 x FLOOR AREA.


22) GYPSUM BOARD SHALL BE FASTENED WITH APPROVED NAILS OR SCREWS SPACED AS PER "UCC REHAB" STANDARDS. PROVIDE WATER RESISTANT BOARD WALLS AND CEILINGS IN

23) ENCLOSE ENTIRE LIVING ENVELOPE WITH A VAPOR BARRIER AND FIBERGLASS BATT INSULATION OF THICKNESS INDICATED. PROVIDE SILL INSULATION. INSULATE ALL

24) INTERIOR STAIRS SHALL HAVE AT LEAST ONE HANDRAIL. RAILINGS AND BALCONIES SHALL BE DESIGNED TO RESIST FORCES OF 200 LBS. HORIZONTAL FORCE.

25) THE CONTRACTOR SHALL PROVIDE ALL BATHROOM TILES

26) SIDING CONTRACTOR SHALL PROVIDE AND INSTALL ALL COMPONENTS OF THE SIDING IN ACCORDANCE WITH MANUFACTURERS INSTALLATION INSTRUCTIONS.

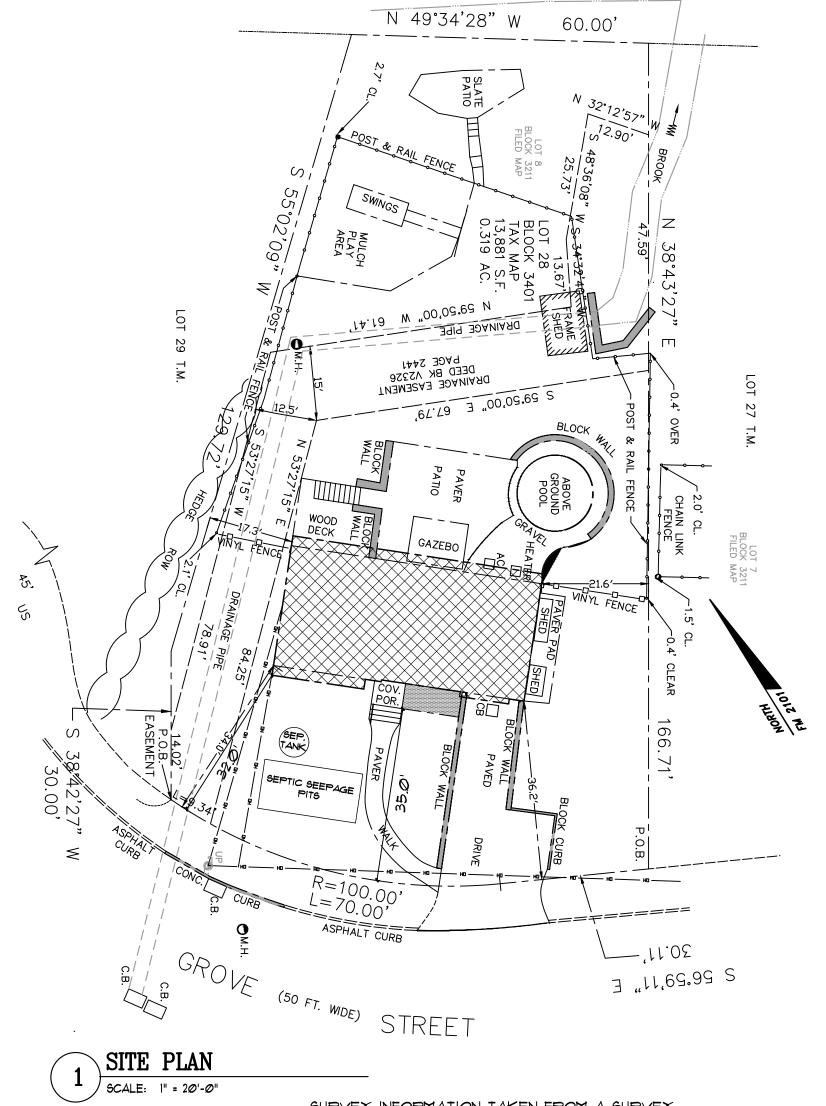


SURVEY INFORMATION TAKEN FROM A SURVEY PREPARED BY: SURVEYOR, STEPHEN EID FROM EID ASSOCIATES INC. DATED Ø4/28/2023

SCHEDULE OF BULK REQUIREMENTS-R-A3 ZONE (RESIDENTIAL)			
	REQUIRED	EXISTING	PROPOSED
MIN. LOT AREA	15,000 SQ.FT	13,881 SQ.FT	13,881 SQFT
MIN. LOT WIDTH	100.01	100.11'	100.11'
MIN. LOT DEPTH	140.0'	159.72'	159.72
FRONT YARD	40.0'	34.00'	32.0' AT CANTILEVER
SIDE YARD	15'	17.3'/21.6'	17.3'/21.6'
MINIMUM REAR YARD	35.0'	103.0'	101.0'
BUILDING COVERAGE	20% ( 2,116 S.F.)	9.7% (1,35Ø S.F.)	11.18% (1,553 S.F.)
IMPERVIOUS COVERAGE	40% ( 5,552 S.F.)	17.61% (2,445 S.F.)	19.07% (2,648 S.F.)
MAX. HEIGHT (FT.)	2.5 STORIES/35.0'	22.Ø'	35.00'

## LEGEND:

- CLG. MOUNTED INCANDESCENT RECESSED LIGHTING FIXTURE AS SELECTED BY OWNER
- PENDANT LIGHTING FIXTURE AS SELECTED BY OWNER
- SCONCE AS SELECTED BY OWNER
- DUPLEX REC. OUTLET
- GROUND FAULT INTERRUPT DUPLEX REC. OUTLET
- ▼ TELEPHONE OUTLET
- SINGLE WAY SWITCH
- THREE WAY SWITCH
- TOUR WAY SWITCH
- JUNCTION BOX FOR LIGHT FIXTURE AS SELECTED BY
- CABLE



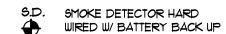





HPS MOTION SENSOR LIGHT. SWITCH TO BE LOCATED BY



\_\_\_\_\_ EXST'G. WALL TO BE REMOVED, PATCH & REPAIR ADJ. SURFACES AS ROR'D. TO

MATCH EXST'G.



NEW WALL, 2"x4" WOOD STUD CONSTRUCTION (UNLESS OTHERWISE NOTED)

AREA OF NEW CONSTRUCTION: 1,385 SF VOLUMNE OF NEW CONSTRUCTION: 11,080 CU/FT USE GROUP-RESIDENTIAL 3 CONST CLASS-5B

CODES USED 2021 IBC NJ EDITION 2021 IRC NJ EDITION 2020 NEC 2021 IECC RESIDENTIAL 2019 ASHRAE 90.1 COMMERCIAL 2021 IMC 2021 IFGC 2017 ANSI A117.1 BARRIER FREE SUBCODE 2021 NSPC NJAC 5:23-6 REHABILITATION SUBCODE NJAC 5:23-7 BARRIER FREE SUBCODE

	ROCKWOOD ARCHITECTURE + DESIGN
	17-15 MAPLE AVENUE FAIR LAWN, NEW JERSEY 07410 (P) 201.773.8303 (F) 201.773.8304
PROJECT:	

REVISION

# MAWHINNEY RESIDENCE

98 GROVE STREET OAKLAND, NEW JERSEY

DRAWING TITLE:


**COVER SHEET** 

SEAL & SIGNATURE

04-05-2023 AS NOTED SCALE: PROJECT No.: 22-153 DRAWING BY: CR DWG No.


CHRISTOPHER RODRIGUEZ NJ LIC. 17519 NY LIC. 34895

DWG: 1 OF 5 PA LIC. 405364

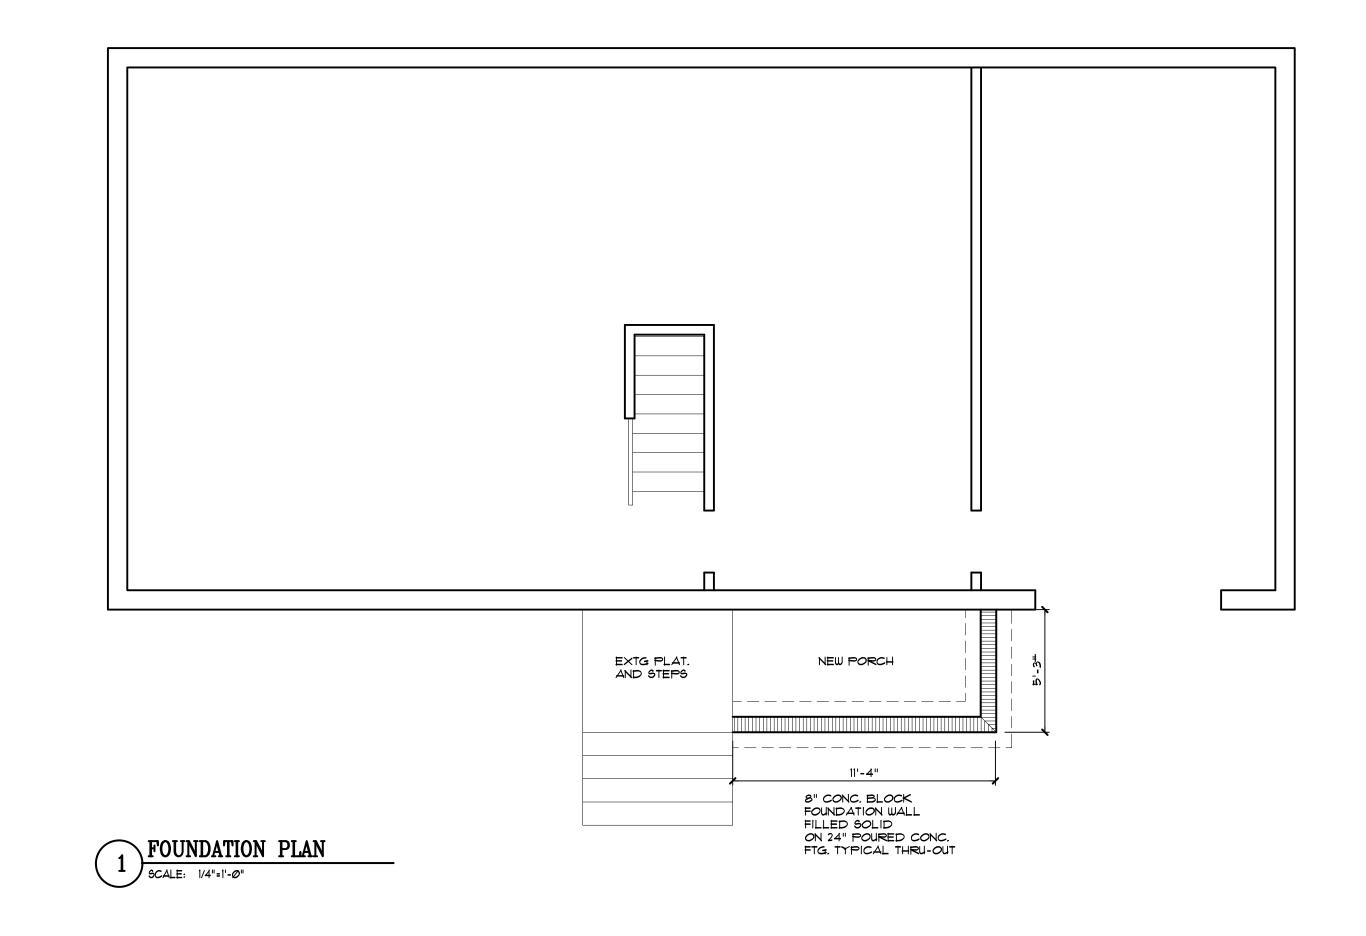


PLUMBING RISER

SCALE: NTS

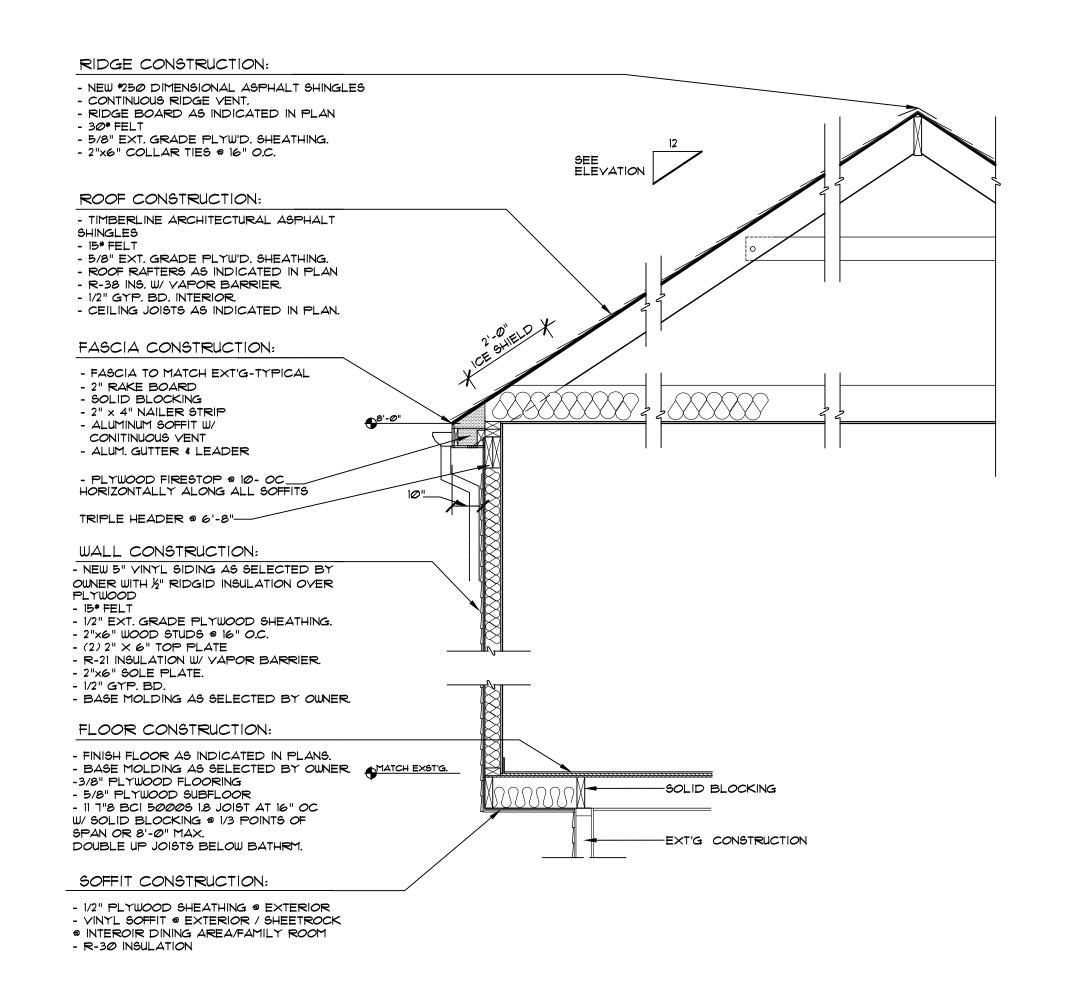


WALL SECTION

SCALE: 1/2"=1'-Ø"

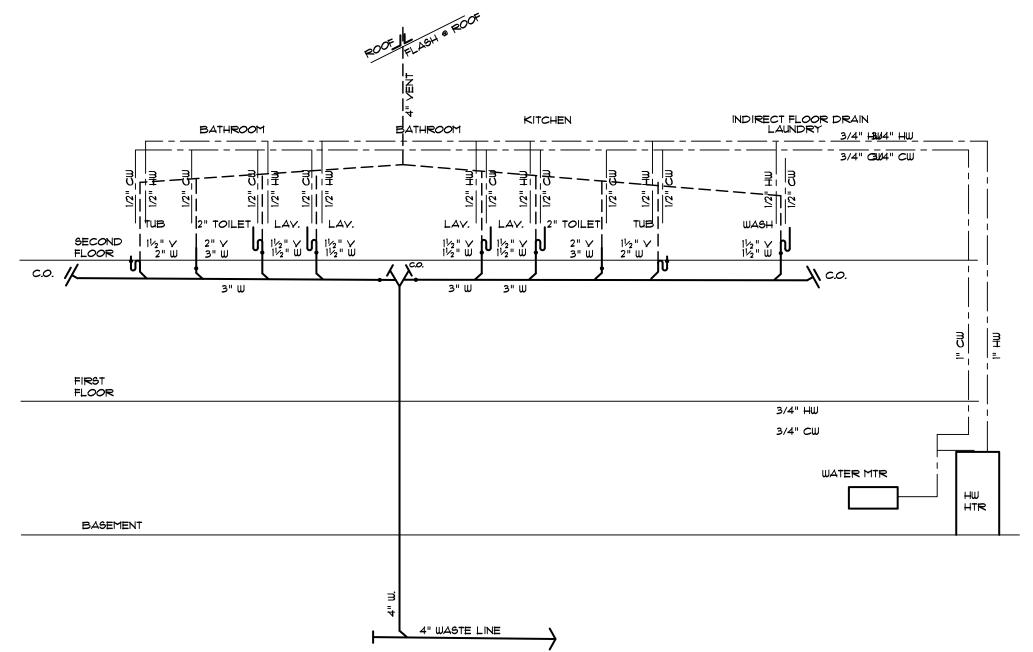





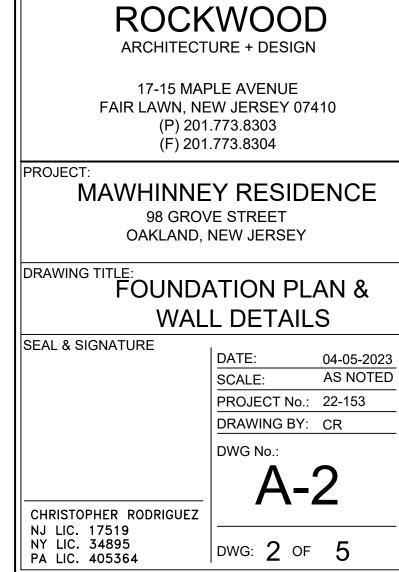


REVISION

DATE:

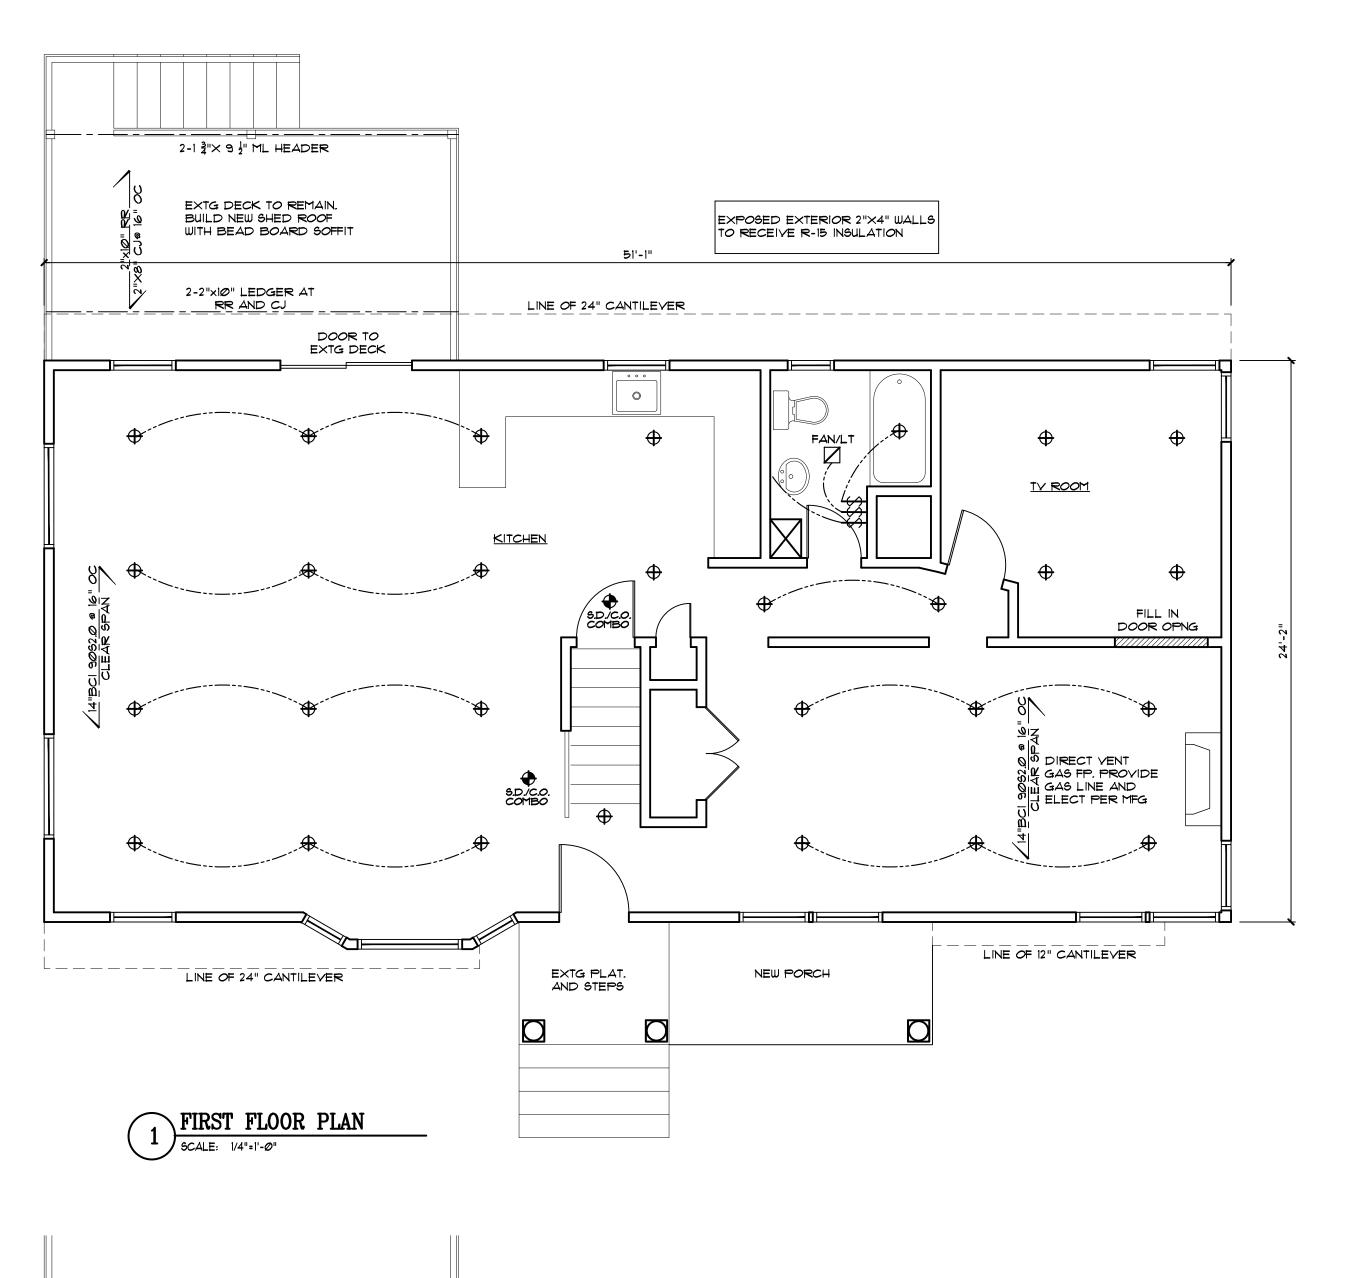

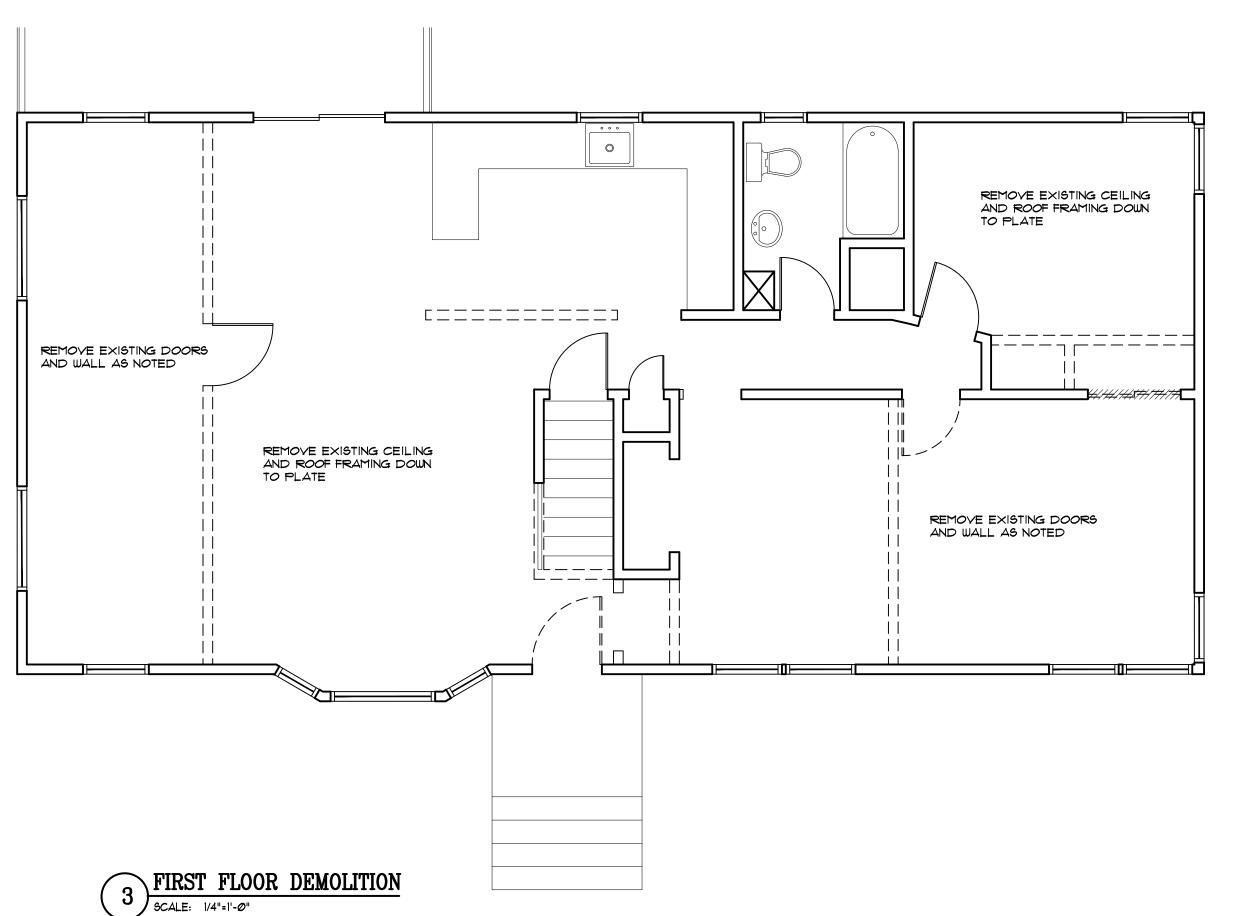

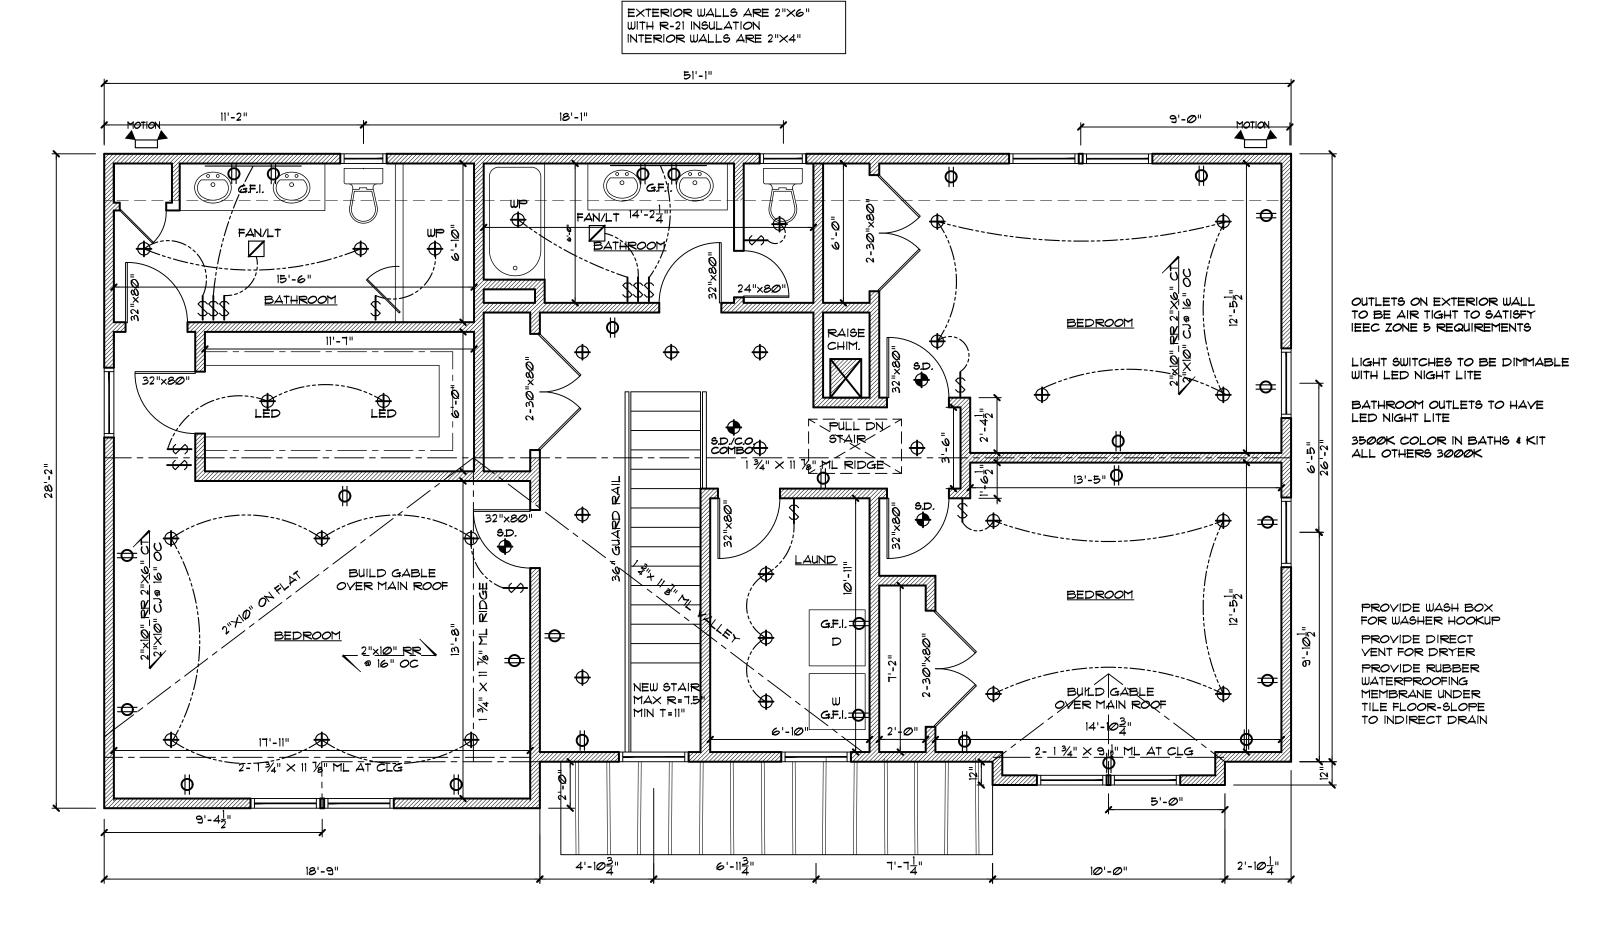

SECOND FLOOR PLAN

GCALE: 1/4"=1'-@"





